BAL 12.5 CONSTRUCTION NOTES:

- <mark>WALLS (INCLUDING GABLES)</mark> AN EXTERNAL WALL SURFACE THAT IS LESS THAN 400mm FROM THE GROUND OR LESS THAN 400mm ABOVE DECKS, CARPORT ROOFS, AWNINGS AND SIMILAR ELEMENTS OR FITTINGS SHALL BE OF NON-COMBUSTIBLE MATERIAL OR MIN. 6mm FIBRE CEMENT SHEET.
- VENTS, WEEPHOLES AND GAPS

WHERE A CIRCULAR PROBE OF 3mm DIAMETER IS CAPABLE OF BEING PASSED THROUGH EXTERNAL VENTS, WEEPHOLES OR GAPS, THE VENTS, WEEPHOLESOR GAPS SHALL BE SCREENED WITH A MESH WITH A MAXIMUM APERTURE OF 2mm, MADE OF CORROSION-RESISTANT STEEL OR BRONZE.

ALL JOINTS IN THE EXTERNAL SURFACE MATERIAL OF WALLS SHALL BE COVERED, SEALED, OVERLAPPED, BACKED OR BUTTJOINTED TO PREVENT GAPS GREATER THAN 3mm. ALTERNATIVELY, SARKING TYPE MATERIAL MAY BE APPLIED OVER THE FRAME PRIOR TO FIXING ANY EXTERNAL CLADDING

WHERE GLAZING IS LESS THAN 400mm FROM THE GROUND OR LESS THAN 400mm ABOVE DECKS, THE GLAZING SHALL BE MIN. 4mm GRADE 'A' SAFETY GLASS OR ANNEALED GLASS. THE OPENABLE PORTIONS OF WINDOWS SHALL BE SCREENED WITH A MESH WITH A MAXIMUM APERTURE OF 2mm, MADE OF CORROSION-RESISTANT STEEL OR BRONZE.

- **DOORS (EXTERNAL SIDE HUNG)** HINGE DOORS SHALL BE SOLID TIMBER, HAVING A MINIMUM THICKNESS OF 35mm FOR THE FIRST 400mm ABOVE THE THRESHOLD. WHERE PART OF THE DOOR ASSEMBLY IS LESS THAN 400mm FROM THE GROUND OR LESS THAN 400mm ABOVE DECKS, THAT PART OF THE DOOR ASSEMBLY SHALL BE MADE FROM BUSHFIRE RESISTING TIMBER OR METAL. WEATHER STRIPS, DRAUGHT EXCLUDERS OR DRAUGHT SEALS SHALL BE INSTALLED AT THE BASE OF SIDE-HUNG EXTERNAL DOORS. DOORS (SUDING)

ANY GLAZING INCORPORATED IN SLIDING DOORS SHALL BE

GRADE 'A' SAFETY GLASS.

THERE IS NO REQUIREMENT TO SCREEN THE OPENABLE PART OF THE SLIDING DOOR.

DOORS (GARAGE) THE LOWER PORTION OF A VEHICLE ACCESS DOOR THAT IS WITHIN 400mm OF THE GROUND WHEN THE DOOR IS CLOSED, SHALL BE MADE FROM NON-COMBUSTIBLE MATERIAL. PANELIFT DOORS SHALL BE FITTED WITH SUITABLE WEATHER STRIPS, DRAUGHT EXCLUDERS, DRAUGHT SEALS OR GUIDE TRACKS WITH A MAXIMUM GAP NO GREATER THAN 3mm.

SHEET ROOFS SHALL BE FULLY SARKED. SARKING IS TO BE LOCATED DIRECTLY BELOW THE ROOF BATTENS AND COVER THE ENTIRE ROOF AREA INCLUDING THE RIDGE. ENSURE THAT THERE ARE NO GAPS THAT WOULD ALLOW THE ENTRY OF

EMBERS WHERE THE SARKING MEETS FASCIAS, GUTTERS, VALLEYS AND THE LIKE. A VERANDAH, CARPORT OR AWNING ROOF SEPERTAED FROM VIHE MAIN ROOF SPACE BY AN EXTERNAL WALL SHALL HAVE A NON-COMBUSTIBLE ROOF COVERING.

ROOF PENETRATIONS

ALL ROOP PENETRATIONS SHALL BE ADEQUATELY SEALED AT THE ROOF TO PREVENT GAPS GREATER THAN 3mm. THE MATERIAL USED TO SEAL THE PENETRATION SHALL BE NON-

EAVES LININGS, FASCIAS AND GABLES

9° 04 ' 32.00mCYCLONE FENCING

JOINTS IN EAVES LININGS, FASCIAS AND GABLES SHALL BE SEALED WITH PLASTIC JOINING STRIPS OR TIMBER STORM

DECKING LESS THAN 300mm (MEASURED HORIZONTALLY) FROM GLAZED ELEMENTS THAT ARE LESS THAN 400mm (MEASURED VERTICALLY) FROM THE SURFACE OF THE DECK SHALL BE MADE FROM NON-COMBUSTIBLE MATERIAL OR

NO FENCE

NOTE:

ALL EASEMENTS & BOUNDARY DETAILS TO BE CONFIRMED WITH COPY OF TITLE PRIOR TO COMENCING CONSTRUCTION.

NOTE:

PRIOR TO STARTING SETOUT FOR CONSTRUCTION CHECK FOR SERVICES WHICH MAY OBSTRUCT DRIVEWAY IF SERVICES ARE GOING TO AFFECT THE RESIDENCE



COBAINS ROAD

This document has been copied and made available for the purpose of the planning process as set out in the Planning and **Environment Act 1987. The information must** not be used for any other purpose.


By taking a copy of this document you acknowledge and agree that you will only use the document for the purpose specified above and that any dissemination, distribution or copying of this document is strictly prohibited.

COMMON PROPERTY 1,000 23,980 5,000 99° 02 '20" 48.71m NO FENCE 2.50 m 2.30 m FACTORY 1 24m x 16m 22.20m 5.00 n F.F.L 10.10 T.B.C ONSITE 384.00 m² n 02.1 9°04 INSIDE SWEPT PATH SHARED DELIVERY 7.60m + 2.514 + 2.518 + 2.518 + 2.518 + 2.518 + 2.518 + 2.518 + 2.518 + 2.518 + 2.518 + 2.518 + 2.518 + 2.518 + 2.518 ARRITRARY DATIIM PT (V) TOP OF N.B.N PIT R.L 10.00 9.96 9.8 F PARKING FIRE HYDRANT × X 5.00 m EXISTING 2.4m CYCLONE FENCING 99° 02 '20" 41.68m **EXISTING 2.4m CYCLONE FENCING** 2.30 m



Lot.5

1524m²

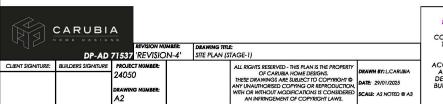

DESIGNATED BUSHFIRE
PROME AREA 12.5
CONSTRUCTION REQUIRMENTS
TO A MIN BAL 12.5 UNDER
AS3959 2018 VIC.
CONSTRUCTION IN
ACCORDANCE WITH SECTION 3
AND 5 OF AS3959-2018 VIC.
DESIGN & CONSTRUCTION OF
BUILDINGS IN BUSHFIRE PROME
AREAS





Member




This document has been copied and made available for the purpose of the planning process as set out in the Planning and **Environment Act 1987. The information must** not be used for any other purpose.

By taking a copy of this document you acknowledge and agree that you will only use the document for the purpose specified above and that any dissemination, distribution or copying of this document is strictly prohibited.

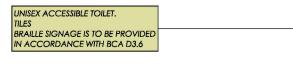

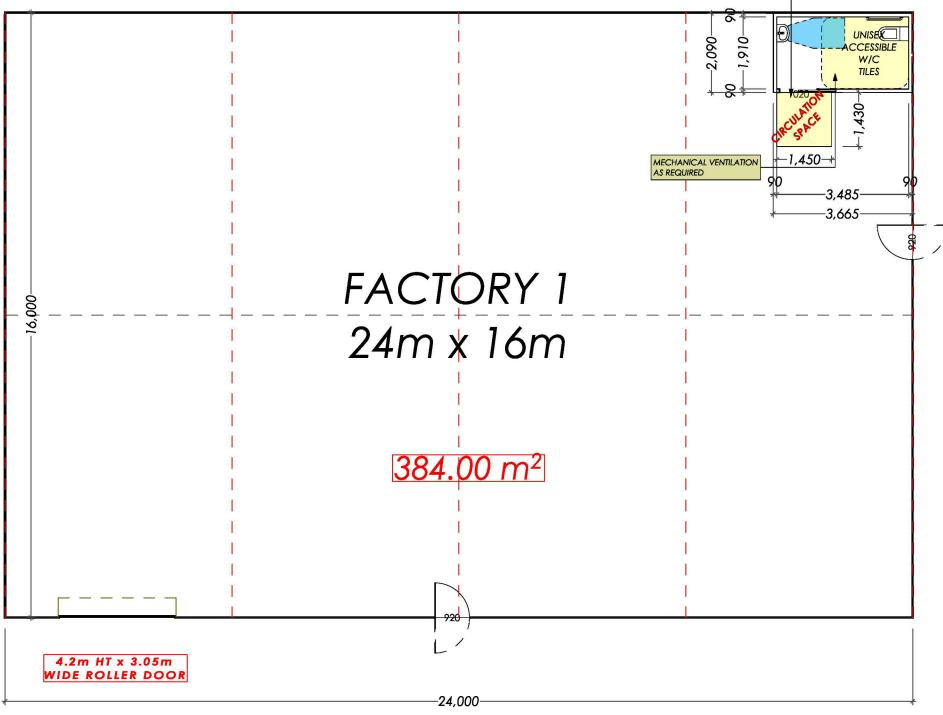

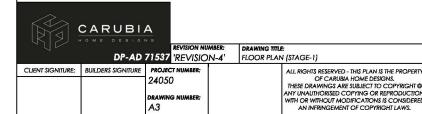

DESIGNATED BUSHFIRE

RAWN BY: L.CARUBIA

CALE: AS NOTED @ A3

DESIGNATED BUSHFIRE
PRONE AREA 12.5
CONSTRUCTION REQUIRMENTS
TO A MIN BAL 12.5 UNDER
AS3959 2018 VIC
CONSTRUCTION IN
ACCORDANCE WITH SECTION 3
AND 5 OF AS3959-2018 VICDESIGN & CONSTRUCTION OF
BUILDINGS IN BUSHFIRE PROME
AREAS

Development Area


Zone Factory 1 Factory 2 Factory 3	m2 468.74 125.80 125.80	Sqr 50.46 13.54 13.54			
			Total Area	720.34	77.54






This document has been copied and made available for the purpose of the planning process as set out in the Planning and Environment Act 1987. The information must not be used for any other purpose.


By taking a copy of this document you acknowledge and agree that you will only use the document for the purpose specified above and that any dissemination, distribution or copying of this document is strictly prohibited.

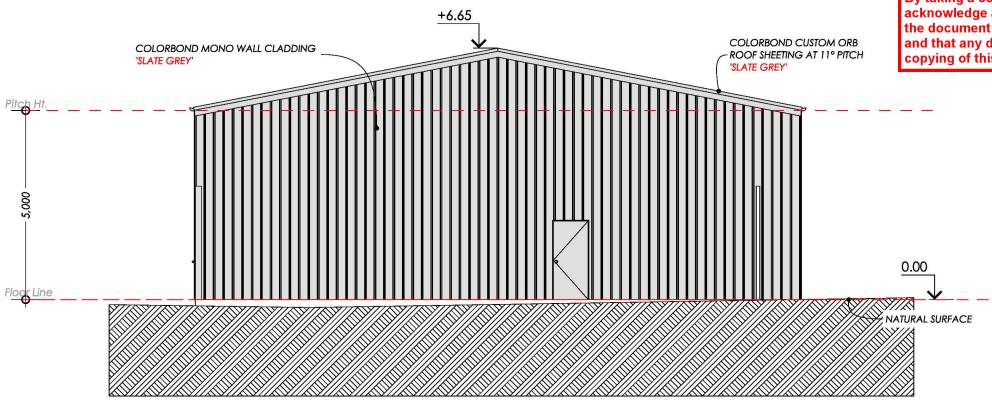


E EAST ELEVATION (STAGE 1)
1:100

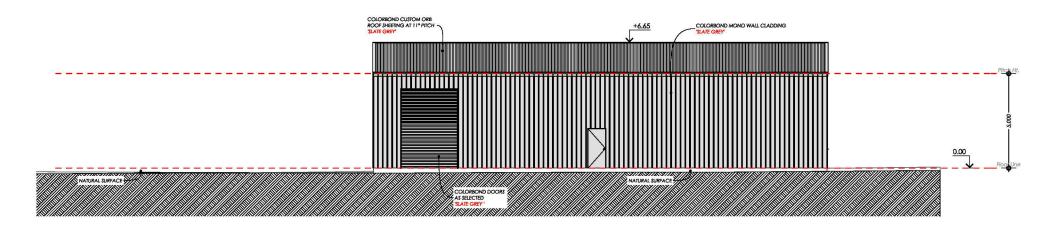



SOUTH ELEVATION (STAGE 1)
1:200

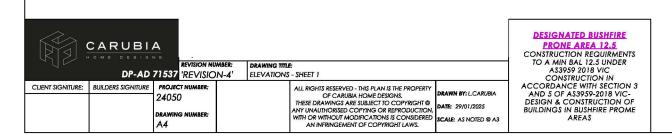



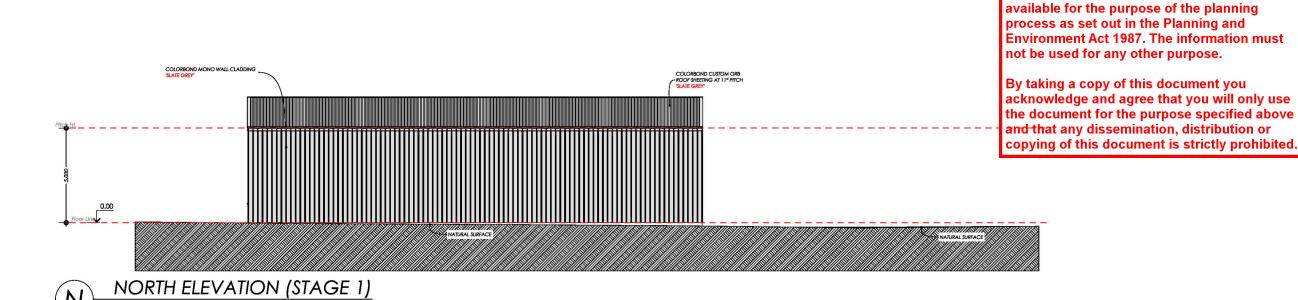


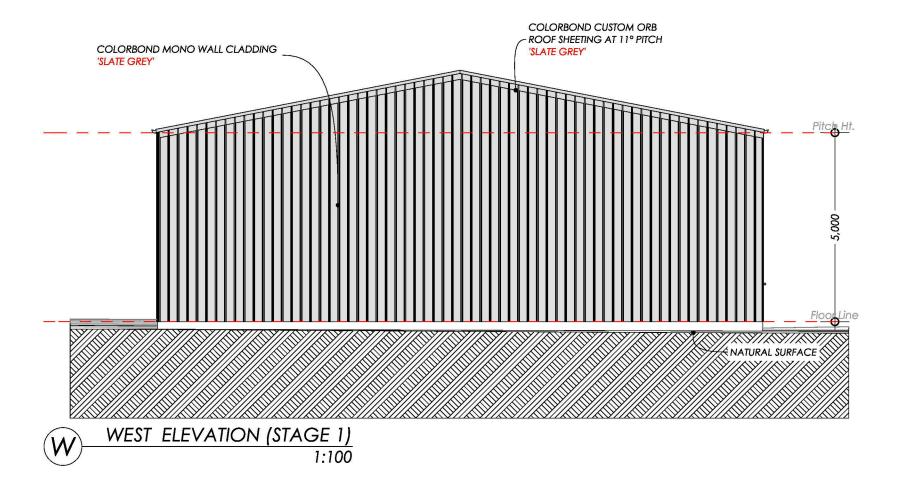


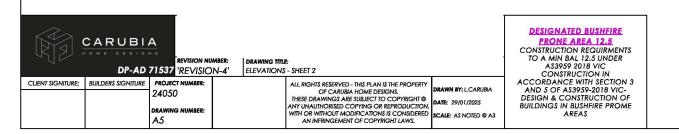



This document has been copied and made

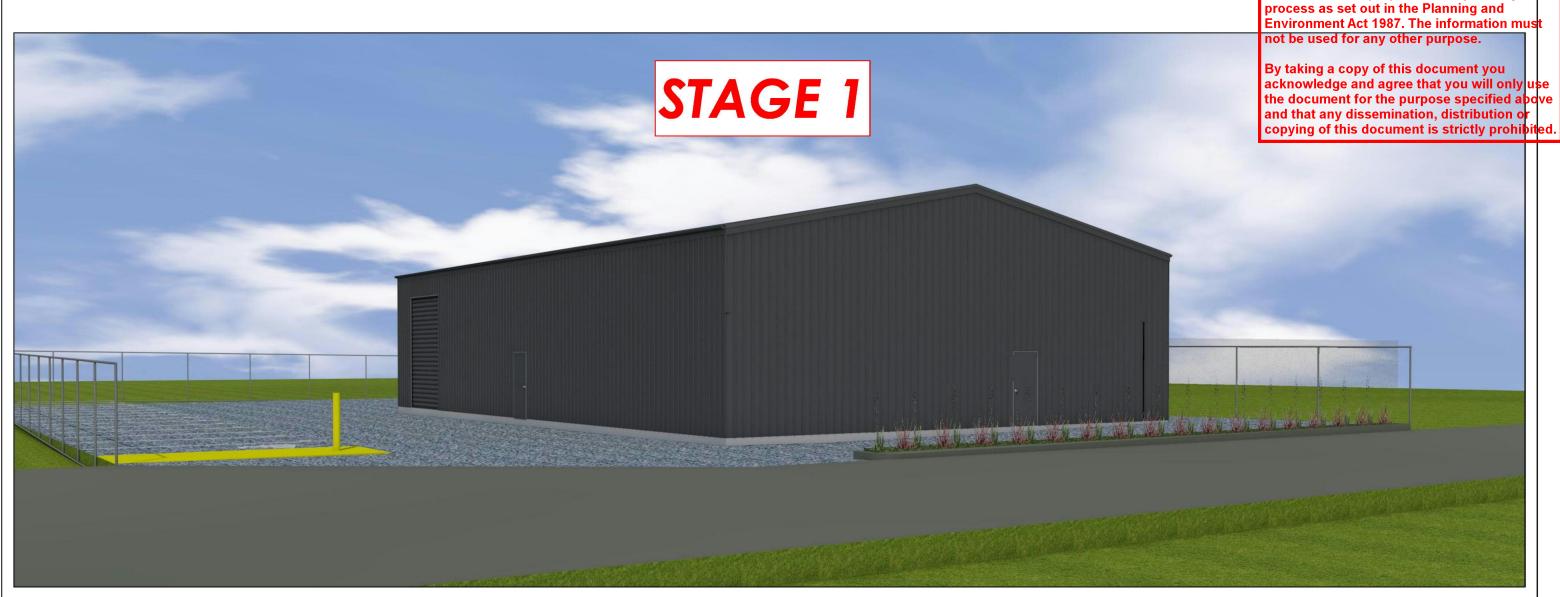

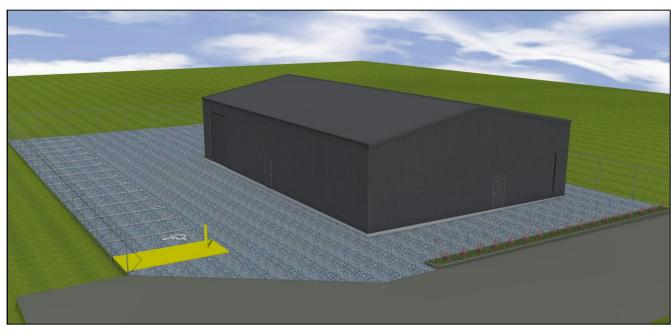

RAWN BY: L.CARUBIA

CALE: AS NOTED @ A3





DP-AD 71537 'REVISION-4'

DRAWING TITLE:
3D PERPECTIVE VIEWS - SHEET 1

CLIENT SIGNITURE: BUILDERS SIGNITURE PROJECT NUA 24050

ALL RIGHTS RESERVED - THIS PLAN IS THE PROPERTY OF CARUBIA HOME DESIGNS. THESE DRAWINGS ARE SUBJECT TO COPYRIGHT © ANY UNAUTHORISED COPYING OR REPRODUCTION, WITH OR WITHOUT MODIFICATIONS IS CONSIDERED AN INFRINGEMENT OF COPYRIGHT LAWS.

DESIGNATED BUSHFIRE
PRONE AREA 12.5
CONSTRUCTION REQUIRMENTS
TO A MIN BAL 12.5 UNDER
AS3959 2018 VIC
CONSTRUCTION IN
ACCORDANCE WITH SECTION 3
AND 5 OF AS3959-2018 VICDESIGN & CONSTRUCTION OF
BUILDINGS IN BUSHFIRE PROME
AREAS

Design Matters **National**

This document has been copied and made available for the purpose of the planning

> The peak body for the building design profess Member

BAL 12.5 CONSTRUCTION NOTES:

- **WALLS (INCLUDING GABLES)** AN EXTERNAL WALL SURFACE THAT IS LESS THAN 400mm FROM THE GROUND OR LESS THAN 400mm ABOVE DECKS, CARPORT ROOFS, AWNINGS AND SIMILAR ELEMENTS OR FITTINGS SHALL BE OF NON-COMBUSTIBLE MATERIAL OR MIN. 6mm FIBRE CEMENT SHEET. - **VENTS, WEEPHOLES AND GAPS**

WHERE A CIRCULAR PROBE OF 3mm DIAMETER IS CAPABLE OF BEING PASSED THROUGH EXTERNAL VENTS, WEEPHOLES OR GAPS, THE VENTS, WEEPHOLESOR GAPS SHALL BE SCREENED WITH A MESH WITH A MAXIMUM APERTURE OF 2mm, MADE OF CORROSION-RESISTANT STEEL OR BRONZE.

ALL JOINTS IN THE EXTERNAL SURFACE MATERIAL OF WALLS SHALL BE COVERED, SEALED, OVERLAPPED, BACKED OR BUTTJOINTED TO PREVENT GAPS GREATER THAN 3mm. ALTERNATIVELY, SARKING TYPE MATERIAL MAY BE APPLIED OVER THE FRAME PRIOR TO FIXING ANY EXTERNAL CLADDING

WHERE GLAZING IS LESS THAN 400mm FROM THE GROUND OR LESS THAN 400mm ABOVE DECKS, THE GLAZING SHALL BE MIN. 4mm GRADE 'A' SAFETY GLASS OR ANNEALED GLASS. THE OPENABLE PORTIONS OF WINDOWS SHALL BE SCREENED WITH A MESH WITH A MAXIMUM APERTURE OF 2mm, MADE OF CORROSION-RESISTANT STEEL OR BRONZE.

- **DOORS (EXTERNAL SIDE HUNG)** HINGE DOORS SHALL BE SOLID TIMBER, HAVING A MINIMUM THICKNESS OF 35mm FOR THE FIRST 400mm ABOVE THE THRESHOLD. WHERE PART OF THE DOOR ASSEMBLY IS LESS THAN 400mm FROM THE GROUND OR LESS THAN 400mm ABOVE DECKS, THAT PART OF THE DOOR ASSEMBLY SHALL BE MADE FROM BUSHFIRE RESISTING TIMBER OR METAL. WEATHER STRIPS, DRAUGHT EXCLUDERS OR DRAUGHT SEALS SHALL BE INSTALLED AT THE BASE OF SIDE-HUNG EXTERNAL DOORS. - DOORS (SUDING)

ANY GLAZING INCORPORATED IN SLIDING DOORS SHALL BE

GRADE 'A' SAFETY GLASS. THERE IS NO REQUIREMENT TO SCREEN THE OPENABLE PART OF

THE SLIDING DOOR. DOORS (GARAGE)

THE LOWER PORTION OF A VEHICLE ACCESS DOOR THAT IS WITHIN 400mm OF THE GROUND WHEN THE DOOR IS CLOSED, SHALL BE MADE FROM NON-COMBUSTIBLE MATERIAL. PANELIFT DOORS SHALL BE FITTED WITH SUITABLE WEATHER STRIPS, DRAUGHT EXCLUDERS, DRAUGHT SEALS OR GUIDE TRACKS WITH A MAXIMUM GAP NO GREATER THAN 3mm.

- **ROOFS** SHEET ROOFS SHALL BE FULLY SARKED. SARKING IS TO BE LOCATED DIRECTLY BELOW THE ROOF BATTENS AND COVER THE ENTIRE ROOF AREA INCLUDING THE RIDGE. ENSURE THAT THERE ARE NO GAPS THAT WOULD ALLOW THE ENTRY OF EMBERS WHERE THE

SARKING MEETS FASCIAS, GUTTERS, VALLEYS AND THE LIKE. A VERANDAH, CARPORT OR AWNING ROOF SEPERTAED FROM VIHE MAIN ROOF SPACE BY AN EXTERNAL WALL SHALL HAVE A NON-COMBUSTIBLE ROOF COVERING. ROOF PENETRATIONS

ALL ROOF PENETRATIONS SHALL BE ADEQUATELY SEALED AT THE ROOF TO PREVENT GAPS GREATER THAN 3mm. THE MATERIAL USED TO SEAL THE PENETRATION SHALL BE NON-

- EAVES LININGS, FASCIAS AND GABLES

9° 04' 32.00mCYCLONE FENCING

JOINTS IN EAVES LININGS, FASCIAS AND GABLES SHALL BE SEALED WITH PLASTIC JOINING STRIPS OR TIMBER STORM

DECKING LESS THAN 300mm (MEASURED HORIZONTALLY) FROM GLAZED ELEMENTS THAT ARE LESS THAN 400mm (MEASURED VERTICALLY) FROM THE SURFACE OF THE DECK SHALL BE MADE FROM NON-COMBUSTIBLE MATERIAL OR

7,865

NO FENCE

Lot.5

1524m²

This document has been copied and made available for the purpose of the planning process as set out in the Planning and **Environment Act 1987. The information must** not be used for any other purpose.

By taking a copy of this document you acknowledge and agree that you will only use the document for the purpose specified above and that any dissemination, distribution or copying of this document is strictly prohibited.



NOTE:


NOTE:

PRIOR TO STARTING SETOUT FOR CONSTRUCTION CHECK FOR SERVICES WHICH MAY OBSTRUCT DRIVEWAY IF SERVICES ARE GOING TO AFFECT THE RESIDENCE

ALL EASEMENTS & BOUNDARY DETAILS

TO BE CONFIRMED WITH COPY OF TITLE

PRIOR TO COMENCING CONSTRUCTION.

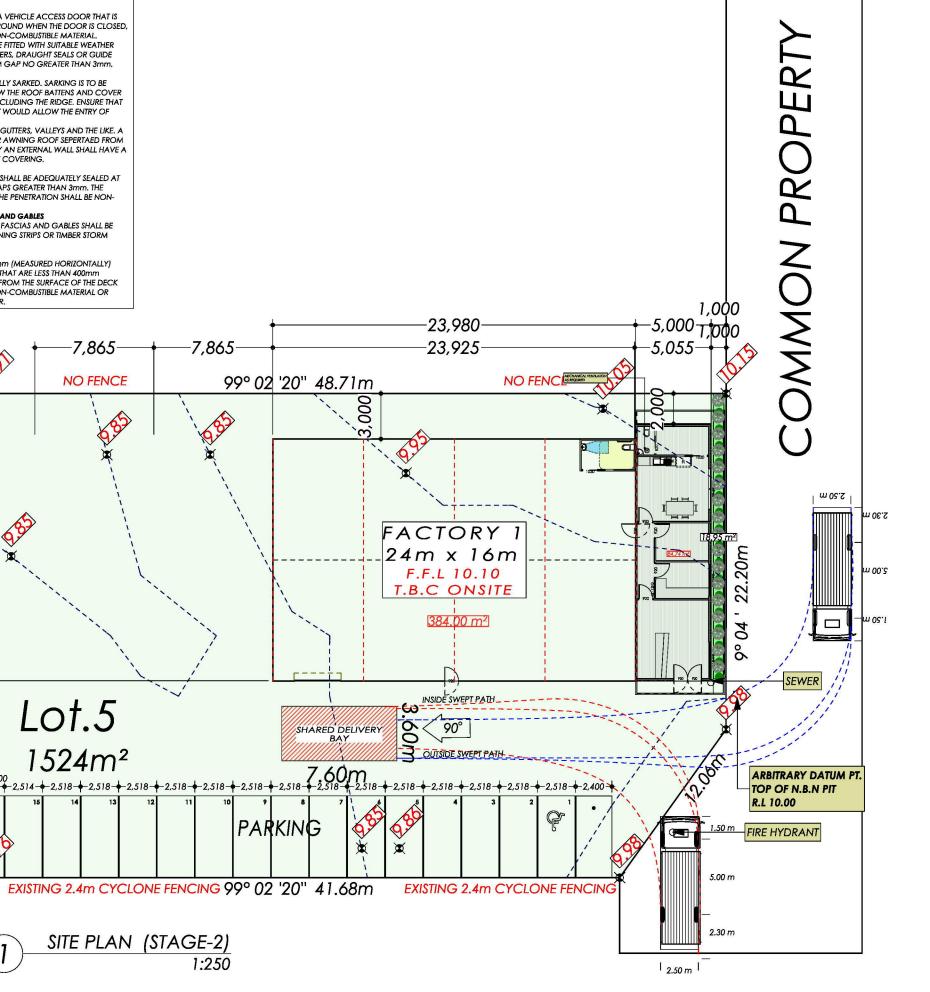



CLIENT SIGNITURE: BUILDERS SIGNITURE PRO


DRAWING TITLE: SITE PLAN (STAGE-2) DP-AD 71537 'REVISION-4' 24050


ALL RIGHTS RESERVED - THIS PLAN IS THE PROPERTY OF CARUBA HOME DESIGNS. THESE DRAWNOS ARE SUBJECT TO COPYRIGHT ® ANY UNAUTHORISED COPYING OR REPRODUCTION WITH OR WITHOUT MODIFICATIONS IS CONSIDERED AN INFRINGEMENT OF COPYRIGHT LAWS. DRAWN BY: L.CARUBIA ATE: 29/01/2025


DESIGNATED BUSHFIRE
PROME AREA 12.5
CONSTRUCTION REQUIRMENTS
TO A MIN BAL 12.5 UNDER
AS3959 2018 VIC
CONSTRUCTION IN
ACCORDANCE WITH SECTION 3
AND 5 OF AS3959-2018 VICDESIGN & CONSTRUCTION OF
BUILDINGS IN BUSHFIRE PROME
AREAS




Member

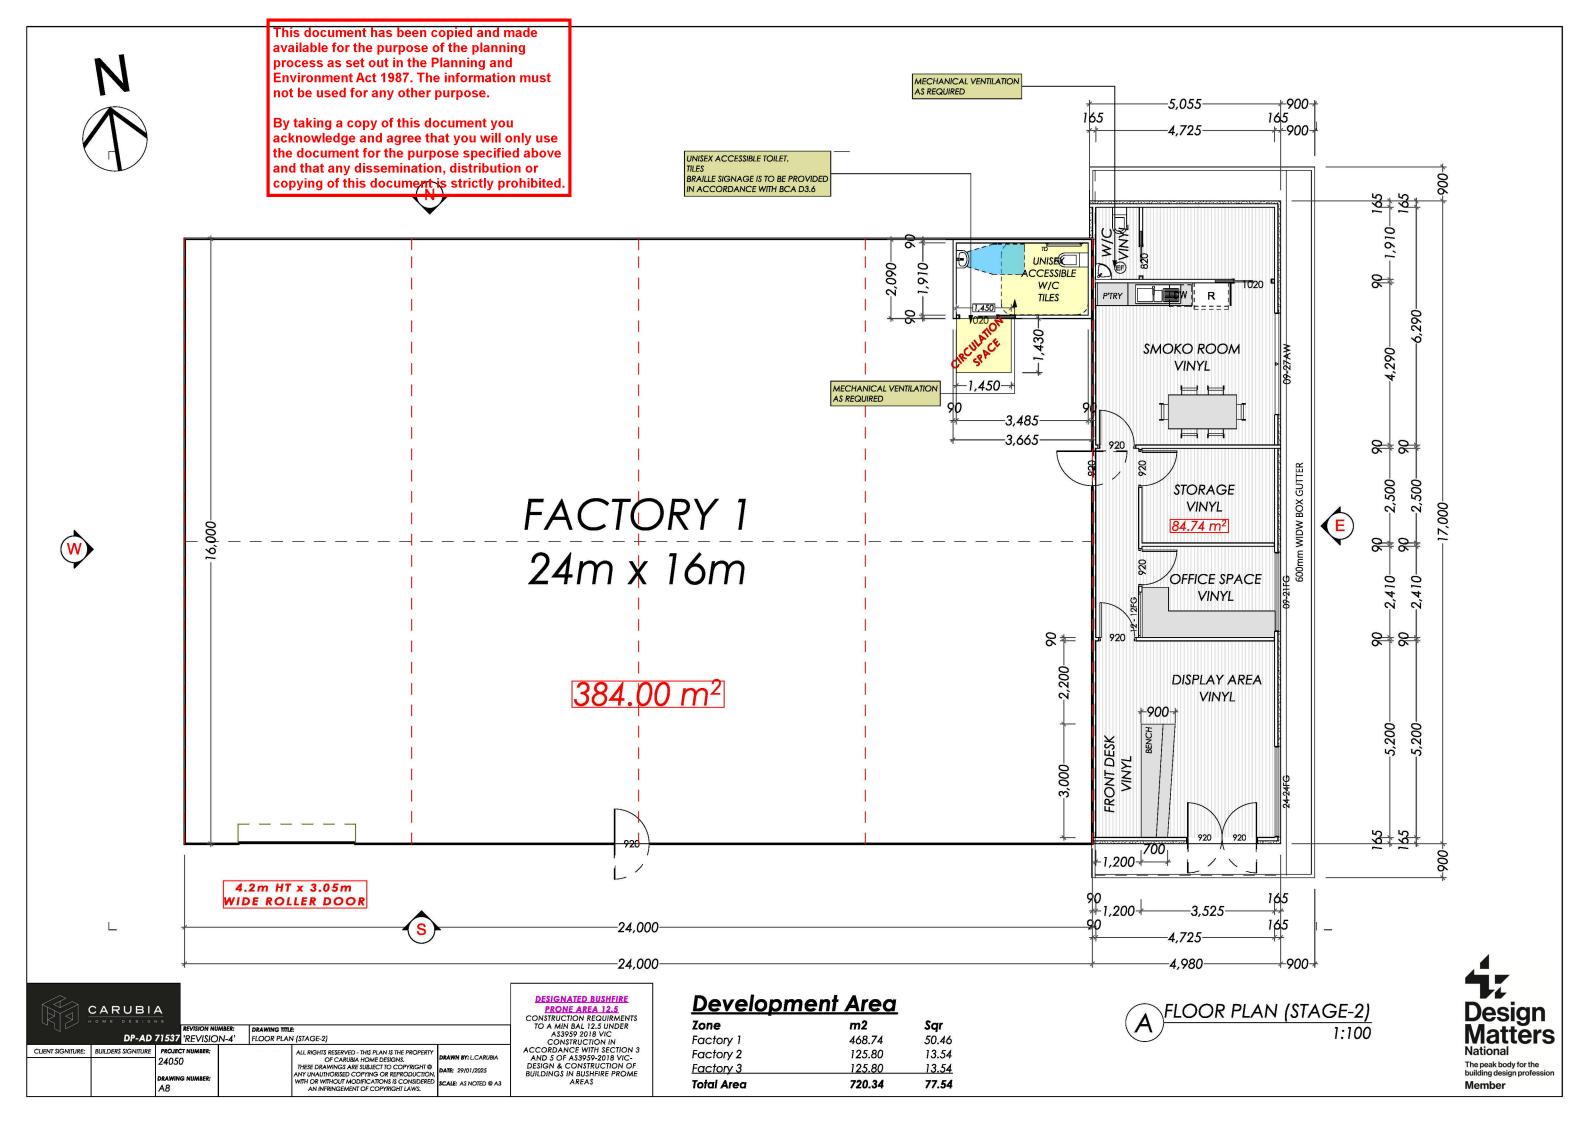

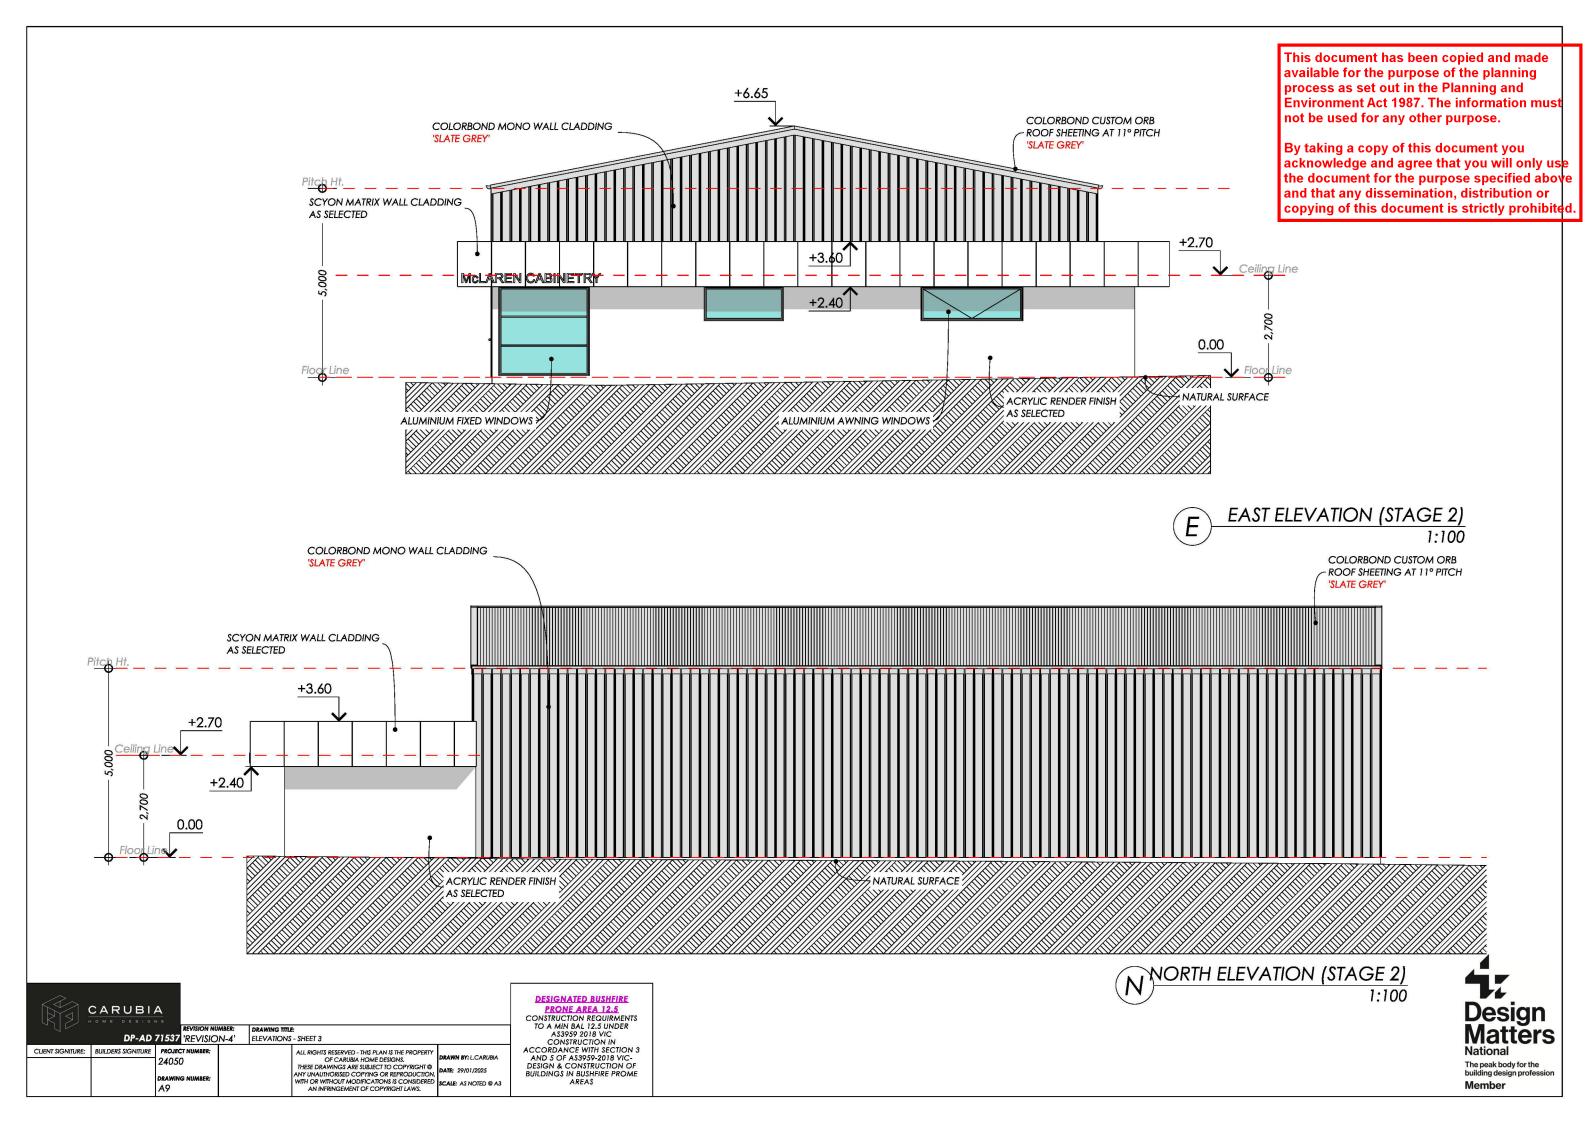

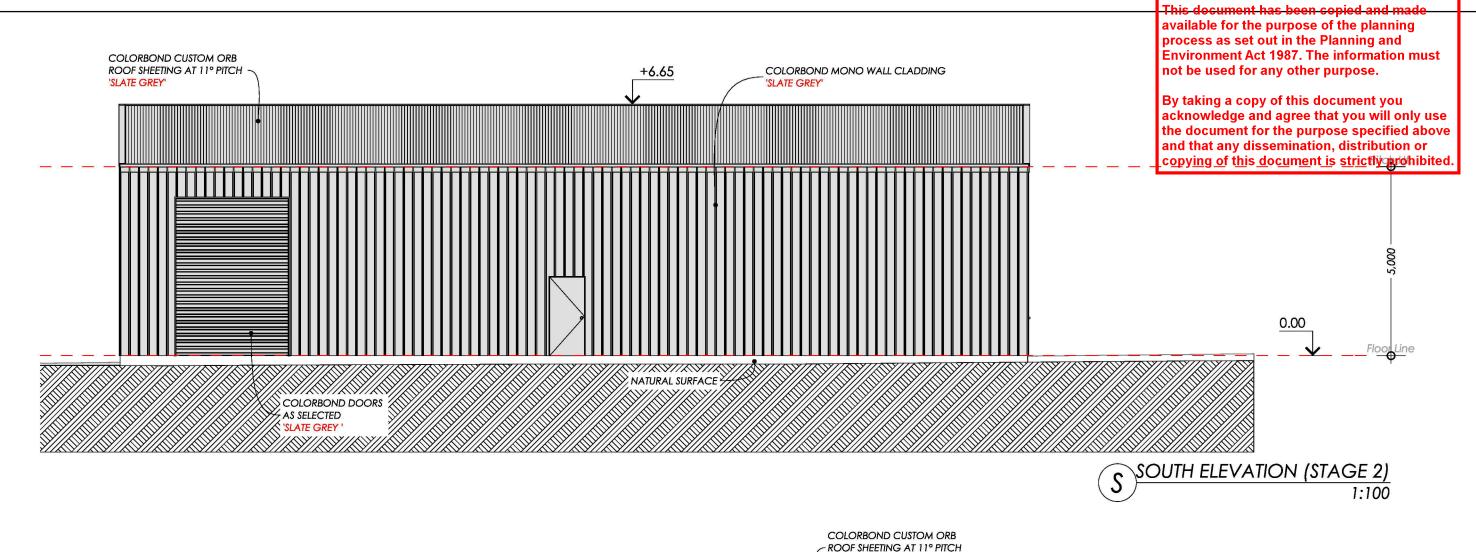

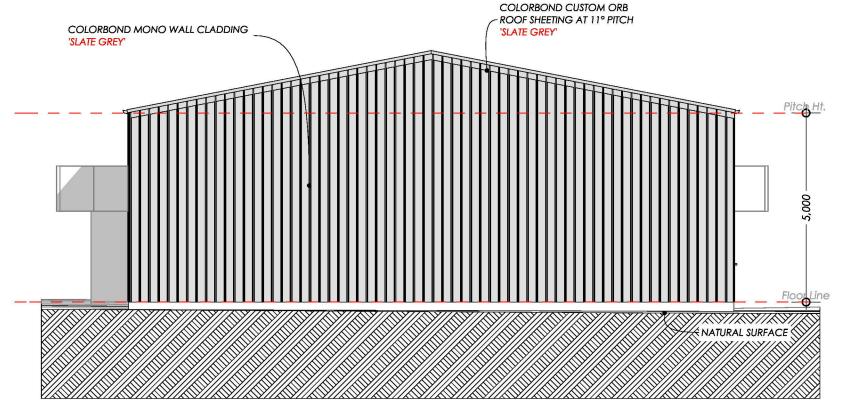

WEST ELEVATION (STAGE 2) 1:100 CARUBIA



DRAWING TITLE: ELEVATIONS - SHEET 4 DP-AD 71537 'REVISION-4' ALL RIGHTS RESERVED - THIS PLAN IS THE PROPERTY OF CARUBA HOME DESIGNS.
THESE DRAWINGS ARE SUBJECT TO COPYRIGHT & ANY UNAUTHORISED COPYING OR REPRODUCTION WITH OR WITHOUT MODIFICATIONS IS CONSIDERED AN INFRINGEMENT OF COPYRIGHT LAWS. CLIENT SIGNITURE: BUILDERS SIGNITURE 24050

A10

RAWN BY: L.CARUBIA SCALE: AS NOTED @ A3 DESIGNATED BUSHFIRE
PRONE AREA 12.5
CONSTRUCTION REQUIRMENTS
TO A MIN BAL 12.5 UNDER
AS3959 2018 VIC
CONSTRUCTION IN
ACCORDANCE WITH SECTION 3
AND 5 OF AS3959-2018 VICDESIGN & CONSTRUCTION OF
BUILDINGS IN BUSHFIRE PROME
AREAS









DP-AD 71537 'REVISION-4'

CLIENT SIGNITURE: BUILDERS SIGNITURE 24050

ALL RIGHTS RESERVED - THIS PLAN IS THE PROPERTY OF CARUBA HOME DESIGNS.
THESE DRAWINGS ARE SUBJECT TO COPYRIGHT ® ANY UNAUTHORISED COPYING OR REPRODUCTION. WITH OR WITHOUT MODIFICATIONS IS CONSIDERED AN INFRINGEMENT OF COPYRIGHT LAWS. RAWN BY: L.CARUBIA SCALE: AS NOTED @ A3

DESIGNATED BUSHFIRE
PRONE AREA 12.5
CONSTRUCTION REQUIRMENTS
TO A MIN BAL 12.5 UNDER
AS3959 2018 VIC
CONSTRUCTION IN
ACCORDANCE WITH SECTION 3
AND 5 OF AS3959-2018 VICDESIGN & CONSTRUCTION OF
BUILDINGS IN BUSHFIRE PROME
AREAS

Design Matters **National**

This document has been copied and made available for the purpose of the planning

> The peak body for the building design profess Member

BAL 12.5 CONSTRUCTION NOTES:

- **WALLS (INCLUDING GABLES)** AN EXTERNAL WALL SURFACE THAT IS LESS THAN 400mm FROM THE GROUND OR LESS THAN 400mm ABOVE DECKS, CARPORT ROOFS, AWNINGS AND SIMILAR ELEMENTS OR FITTINGS SHALL BE OF NON-COMBUSTIBLE MATERIAL OR MIN. 6mm FIBRE CEMENT SHEET. - **VENTS, WEEPHOLES AND GAPS**

WHERE A CIRCULAR PROBE OF 3mm DIAMETER IS CAPABLE OF BEING PASSED THROUGH EXTERNAL VENTS, WEEPHOLES OR GAPS, THE VENTS, WEEPHOLESOR GAPS SHALL BE SCREENED WITH A MESH WITH A MAXIMUM APERTURE OF 2mm, MADE OF CORROSION-RESISTANT STEEL OR BRONZE.

ALL JOINTS IN THE EXTERNAL SURFACE MATERIAL OF WALLS
SHALL BE COVERED, SEALED, OVERLAPPED, BACKED OR BUTTJOINTED TO PREVENT GAPS GREATER THAN 3mm. ALTERNATIVELY, SARKING TYPE MATERIAL MAY BE APPLIED OVER THE FRAME PRIOR TO FIXING ANY EXTERNAL CLADDING.

WHERE GLAZING IS LESS THAN 400mm FROM THE GROUND OR LESS THAN 400mm ABOVE DECKS, THE GLAZING SHALL BE MIN. 4mm GRADE 'A' SAFETY GLASS OR ANNEALED GLASS. THE OPENABLE PORTIONS OF WINDOWS SHALL BE SCREENED WITH A MESH WITH A MAXIMUM APERTURE OF 2mm, MADE OF CORROSION-RESISTANT STEEL OR BRONZE.

- **DOORS (EXTERNAL SIDE HUNG)** HINGE DOORS SHALL BE SOLID TIMBER, HAVING A MINIMUM THICKNESS OF 35mm FOR THE FIRST 400mm ABOVE THE THRESHOLD. WHERE PART OF THE DOOR ASSEMBLY IS LESS THAN 400mm FROM THE GROUND OR LESS THAN 400mm ABOVE DECKS, THAT PART OF THE DOOR ASSEMBLY SHALL BE MADE FROM BUSHFIRE RESISTING TIMBER OR METAL. WEATHER STRIPS, DRAUGHT EXCLUDERS OR DRAUGHT SEALS SHALL BE INSTALLED AT THE BASE OF SIDE-HUNG EXTERNAL DOORS. DOORS (SUDING)

ANY GLAZING INCORPORATED IN SLIDING DOORS SHALL BE

GRADE 'A' SAFETY GLASS. THERE IS NO REQUIREMENT TO SCREEN THE OPENABLE PART OF

THE SLIDING DOOR. DOORS (GARAGE)

THE LOWER PORTION OF A VEHICLE ACCESS DOOR THAT IS WITHIN 400mm OF THE GROUND WHEN THE DOOR IS CLOSED, SHALL BE MADE FROM NON-COMBUSTIBLE MATERIAL. PANELIFT DOORS SHALL BE FITTED WITH SUITABLE WEATHER STRIPS, DRAUGHT EXCLUDERS, DRAUGHT SEALS OR GUIDE TRACKS WITH A MAXIMUM GAP NO GREATER THAN 3mm.

SHEET ROOFS SHALL BE FULLY SARKED. SARKING IS TO BE LOCATED DIRECTLY BELOW THE ROOF BATTENS AND COVER THE ENTIRE ROOF AREA INCLUDING THE RIDGE. ENSURE THAT THERE ARE NO GAPS THAT WOULD ALLOW THE ENTRY OF EMBERS WHERE THE

SARKING MEETS FASCIAS, GUTTERS, VALLEYS AND THE LIKE. A VERANDAH, CARPORT OR AWNING ROOF SEPERTAED FROM THE MAIN ROOF SPACE BY AN EXTERNAL WALL SHALL HAVE A NON-COMBUSTIBLE ROOF COVERING. **ROOF PENETRATIONS**

ALL ROOF PENETRATIONS SHALL BE ADEQUATELY SEALED AT THE ROOF TO PREVENT GAPS GREATER THAN 3mm. THE MATERIAL USED TO SEAL THE PENETRATION SHALL BE NON-

EAVES LININGS, FASCIAS AND GABLES

JOINTS IN EAVES LININGS, FASCIAS AND GABLES SHALL BE SEALED WITH PLASTIC JOINING STRIPS OR TIMBER STORM

DECKING LESS THAN 300mm (MEASURED HORIZONTALLY) FROM GLAZED ELEMENTS THAT ARE LESS THAN 400mm (MEASURED VERTICALLY) FROM THE SURFACE OF THE DECK SHALL BE MADE FROM NON-COMBUSTIBLE MATERIAL OR NOTE:

ALL EASEMENTS & BOUNDARY DETAILS TO BE CONFIRMED WITH COPY OF TITLE PRIOR TO COMENCING CONSTRUCTION.

NOTE:

PRIOR TO STARTING SETOUT FOR CONSTRUCTION CHECK FOR SERVICES WHICH MAY OBSTRUCT DRIVEWAY IF SERVICES ARE GOING TO AFFECT THE RESIDENCE



COBAINS ROAD

This document has been copied and made

By taking a copy of this document you acknowledge and agree that you will only use the document for the purpose specified above and that any dissemination, distribution or copying of this document is strictly prohibited.

available for the purpose of the planning process as set out in the Planning and **Environment Act 1987. The information must** not be used for any other purpose.

COMMON PROPERTY 1,000 -5,000 1,000 23,980 7,865 7,865 23,925 5,055 99° 02 '20" 48.71m NO FENCE NO FENCE 9° 04' 32.00mCYCLONE FENCING 3,000 5 m E 2.50 m 5 36. 10 10 SIT 2.30 m 9 FACTORY 1 S 8 8 S 8. Z 24m x 16m F.F.L 10.10 5.00 r T.B.C ONSITE E 384.00 m² n 02.1 9°04 9 9 INSIDE SWEPT PATH. Lot.5 SHARED DELIVERY 1524m² OUTSIDE SWEPT PATH 7.60mARRITRARY DATIM PT 1. 20 TOP OF N.B.N PIT 9.85 R.L 10.00 9.86 P PARKING FIRE HYDRANT × X 5.00 m EXISTING 2.4m CYCLONE FENCING 99° 02 '20" 41.68m **EXISTING 2.4m CYCLONE FENCING** SITE PLAN (STAGE-3) 2.30 m



DRAWING TITLE: SITE PLAN (STAGE-3) DP-AD 71537 'REVISION-4' ALL RIGHTS RESERVED - THIS PLAN IS THE PROPERTY OF CARUBA HOME DESIGNS. THESE DRAWNOS ARE SUBJECT TO COPYRIGHT ® ANY UNAUTHORISED COPYING OR REPRODUCTION WITH OR WITHOUT MODIFICATIONS IS CONSIDERED AN INFRINGEMENT OF COPYRIGHT LAWS. DRAWN BY: L.CARUBIA 24050 ATE: 29/01/2025

DESIGNATED BUSHFIRE
PROME AREA 12.5
CONSTRUCTION REQUIRMENTS
TO A MIN BAL 12.5 UNDER
AS3959 2018 VIC.
CONSTRUCTION IN
ACCORDANCE WITH SECTION 3
AND 5 OF AS3959-2018 VIC.
DESIGN & CONSTRUCTION OF
BUILDINGS IN BUSHFIRE PROME
AREAS






O NOT SCALE

This document has been copied and made available for the purpose of the planning process as set out in the Planning and **Environment Act 1987. The information must** not be used for any other purpose.

By taking a copy of this document you acknowledge and agree that you will only use the document for the purpose specified above and that any dissemination, distribution or copying of this document is strictly prohibited.

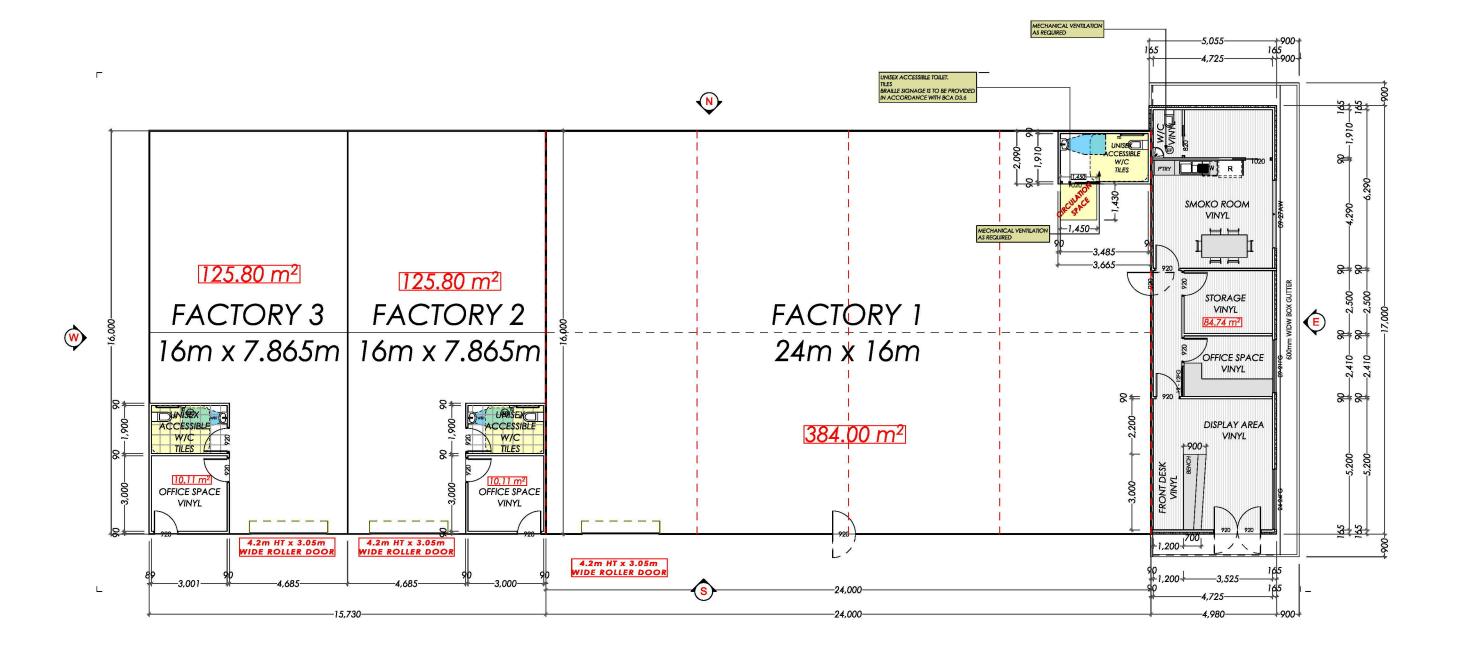



FLOOR PLAN (STAGE-3)

CARUBIA

DRAWING TITLE: FLOOR PLAN (STAGE- 3)

DP-AD 71537 'REVISION-4' CLIENT SIGNITURE: BUILDERS SIGNITURE 24050

ALL RIGHTS RESERVED - THIS PLAN IS THE PROPERTY OF CARUBA HOME DESIGNS. THESE DRAWINGS ARE SUBJECT TO COPYRIGHT OF ANY UNAUTHORISED COPYING OR REPRODUCTION WITH OR WITHOUT MODIFICATIONS IS CONSIDERED AN INFRINGEMENT OF COPYRIGHT LAWS. RAWN BY: L.CARUBIA CALE: AS NOTED @ A3 DESIGNATED BUSHFIRE **Development Area**

DESIGNATED BUSHFIRE
PRONE AREA 12.5
CONSTRUCTION REQUIRMENTS
TO A MIN BAL 12.5 UNDER
AS3959 2018 VIC
CONSTRUCTION IN
ACCORDANCE WITH SECTION 3
AND 5 OF AS3959-2018 VICDESIGN & CONSTRUCTION OF
BUILDINGS IN BUSHFIRE PROME
AREAS Zone m2 Factory 1 468.74 Factory 2 125.80 Factory 3 125.80 Total Area 720.34

Sqr


50.46

13.54


13.54

77.54




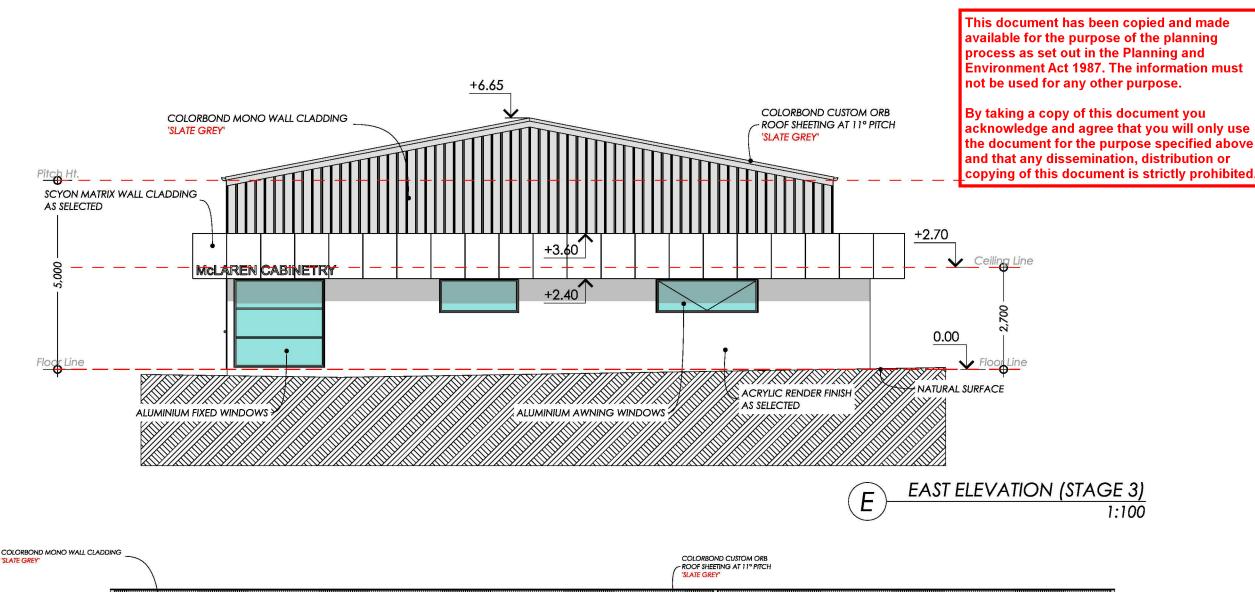


NORTH ELEVATION (STAGE 3)

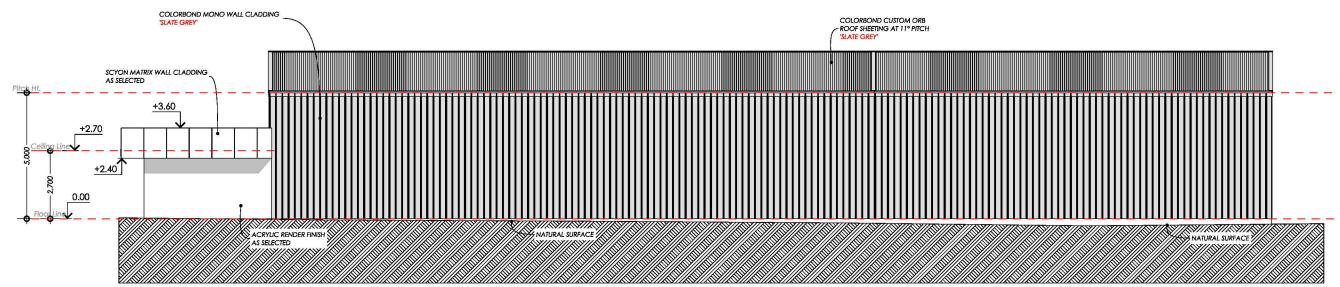



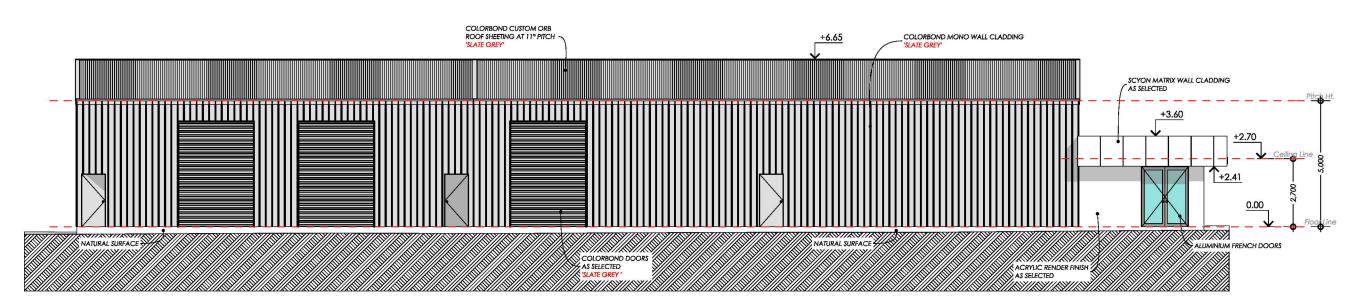



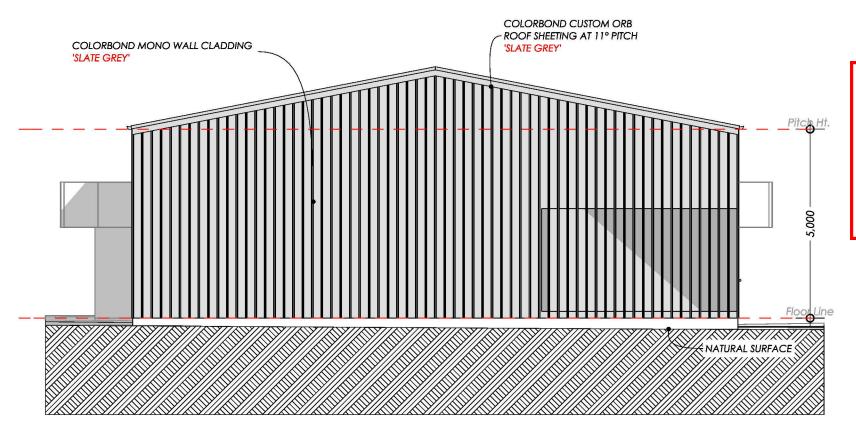

This document has been copied and made available for the purpose of the planning process as set out in the Planning and Environment Act 1987. The information must not be used for any other purpose.

By taking a copy of this document you acknowledge and agree that you will only use the document for the purpose specified above and that any dissemination, distribution or copying of this document is strictly prohibited.



REVISION NUMBER: DRAWING TITLE:

DP-AD 71537 'REVISION-4' ELEVATIONS - SHEET 6

SIGNITURE PROJECT NUMBER: ALL RIGHTS RE

CLIENT SIGNITURE: BUILDERS SIGNITURE

PROJECT NUMBER:
24050

DRAWING NUMBER:
A 15

ALL RIGHTS RESERVED - THIS PLAN IS THE PROPERTY
OF CARUBA HOME DESIGNS.
THESE DRAWINGS ARE SUBJECT TO COPYRIGHT ©
ANY UNAUTHSEE COPYRIGE OF REPRODUCTION
WITH OR WITHOUT MODIFICATIONS IS CONSIDERED
AN INFRINGEMENT OF COPYRIGHT LAWS.

DESIGNATED BUSHFIRE
PRONE AREA 12.5
CONSTRUCTION REQUIRMENTS
TO A MIN BAL 12.5 UNDER
AS3959 2018 VIC
CONSTRUCTION IN
ACCORDANCE WITH SECTION 3
AND 5 OF AS3959-2018 VICDESIGN & CONSTRUCTION OF
BUILDINGS IN BUSHFIRE PROME
AREAS

RAWN BY: L.CARUBIA


SCALE: AS NOTED @ A3









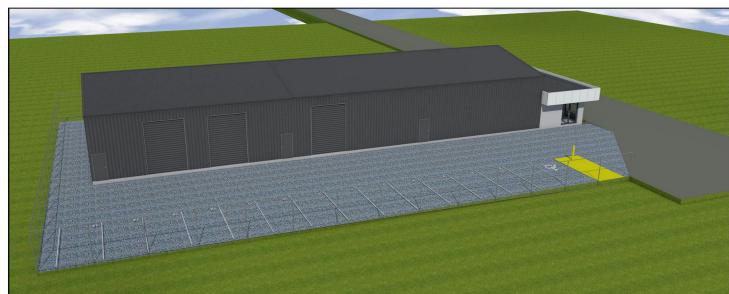



DP-AD 71537 'REVISION-4' CLIENT SIGNITURE: BUILDERS SIGNITURE 24050


ALL RIGHTS RESERVED - THIS PLAN IS THE PROPERTY OF CARUBA HOME DESIGNS.
THESE DRAWINGS ARE SUBJECT TO COPYRIGHT ® ANY UNAUTHORISED COPYING OR REPRODUCTION. WITH OR WITHOUT MODIFICATIONS IS CONSIDERED AN INFRINGEMENT OF COPYRIGHT LAWS. RAWN BY: L.CARUBIA

CALE: AS NOTED @ A3

DESIGNATED BUSHFIRE
PRONE AREA 12.5
CONSTRUCTION REQUIRMENTS
TO A MIN BAL 12.5 UNDER
AS3959 2018 VIC
CONSTRUCTION IN
ACCORDANCE WITH SECTION 3
AND 5 OF AS3959-2018 VICDESIGN & CONSTRUCTION OF
BUILDINGS IN BUSHFIRE PROME
AREAS



The peak body for the building design profess Member

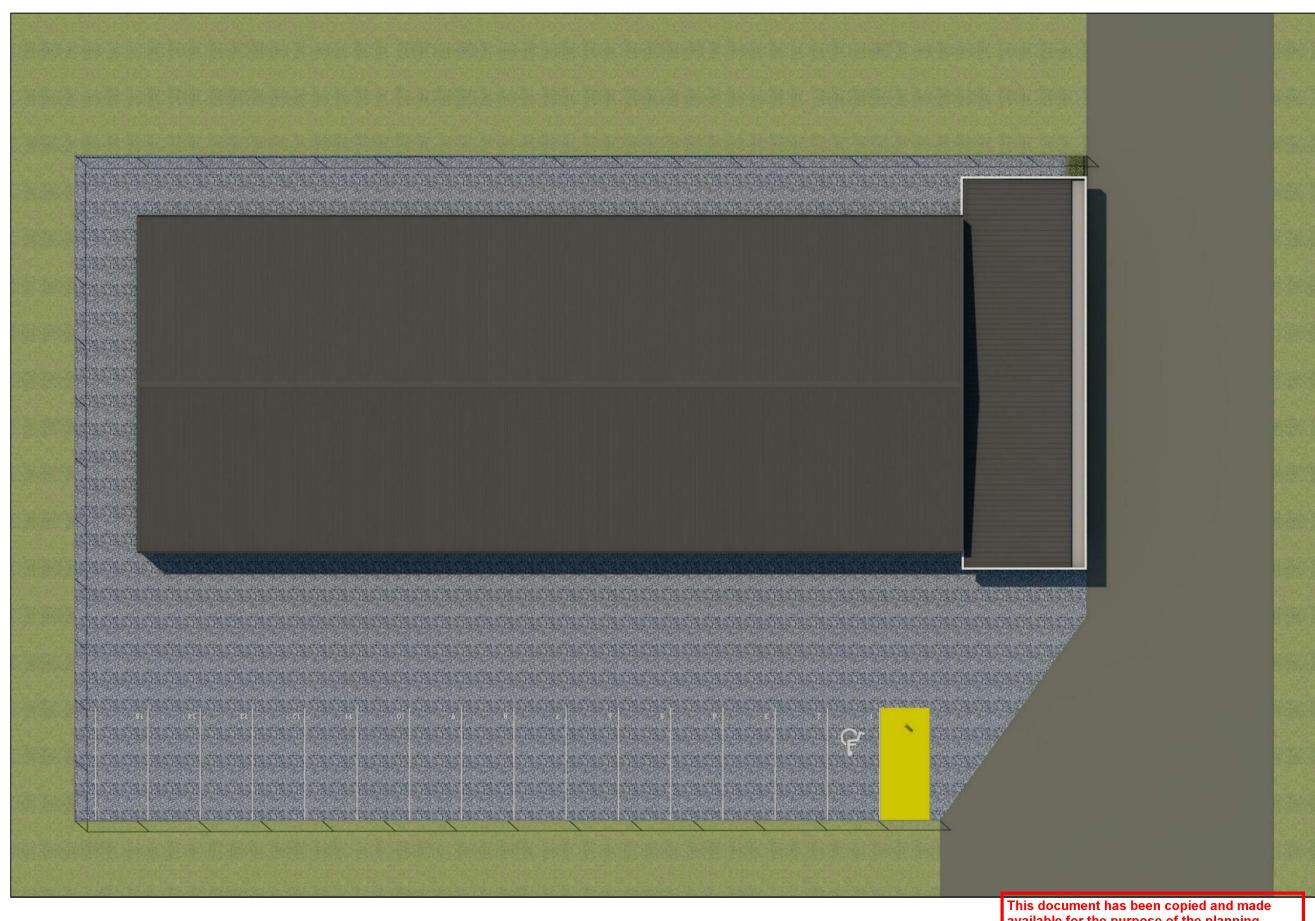



DRAWING TITLE:
3D PERPECTIVE VIEWS - SHEET 5

DP-AD 71537 'REVISION-4' CLIENT SIGNITURE: BUILDERS SIGNITURE 24050

ALL RIGHTS RESERVED - THIS PLAN IS THE PROPERTY OF CARUBIA HOME DESIGNS. THESE DRAWINGS ARE SUBJECT TO COPYRIGHT © ANY UNAUTHORISED COPYING OR REPRODUCTION. WITH OR WITHOUT MODIFICATIONS IS CONSIDERED AN INFRINGEMENT OF COPYRIGHT LAWS. DRAWN BY: L.CARUBIA SCALE: AS NOTED @ A3

DESIGNATED BUSHFIRE
PRONE AREA 12.5
CONSTRUCTION REQUIRMENTS
TO A MIN BAL 12.5 UNDER
AS3959 2018 VIC
CONSTRUCTION IN
ACCORDANCE WITH SECTION 3
AND 5 OF AS3959-2018 VICDESIGN & CONSTRUCTION OF
BUILDINGS IN BUSHFIRE PROME
AREAS

available for the purpose of the planning process as set out in the Planning and Environment Act 1987. The information must not be used for any other purpose.

By taking a copy of this document you acknowledge and agree that you will only use the document for the purpose specified above and that any dissemination, distribution or copying of this document is strictly prohibited.



Member